



FII E INE

BUILDERS' INFORM

S DRAWING IS COPYRIGHTED AND MAY ONLY BE
ED TO CONSTRUCT THE BUILDING AS INTENDED
MAY NOT SELL, RESELL OR USE THIS DRAWING
ANY COMMERCIAL USE. THIS DRAWING MAY
'Y BE USED FOR PERSONAL USE.

x 24' HORSE STABLE with LEAN-TO

SEA

PROJECT NO.

DRAWN BY

FILE INFO.

REVISIONS

DRAWING TITLE

IMAGES

SHEET NO.

BEFORE USING THIS PLAN:

- 1. YOU MUST FIRST CONFIRM THIS PLAN FOR CODE COMPLIANCE WITH AN ENGINEER OR YOUR LOCAL CODE OFFICIAL.
- THIS PLAN IS NOT DESIGNED FOR HIGH WIND ZONES AND WILL NEED TO BE MODIFIED BY AN ENGINEER OR AN ARCHITECT TO COMPLY WITH HIGH WIND ZONE CODES.
- 3. IF THIS PLAN IS USED AS-IS WITHOUT FIRST CONFIRMING WITH AN ENGINEER, END USER SHALL BE FULLY RESPONSIBLE FOR ANY OR ALL CONSEQUENCES THAT MIGHT ARISE OUT OF USE OF THIS PLAN.

30'x24' HORSE STABLE WITH 10' LEAN-TO

By using these plans you agree not to hold Keystone Barn Supply, LLC, it's owners and/or plan designers responsible for any mistakes or incorrect design. You also agree that Keystone Barn Supply LLC, its owners or plan designers will not be, under any circumstances liable to the consumer or end user for any incidental, consequential, special, exemplary, or punitive damages arising out of the use of these plans. You MUST ALWAYS consult with your local engineer and your contractor before using any of our plans or doing any construction work.

NOTES:

GENERAL NOTES - AGRICULTURAL BUILDING

- 1. PROVIDE EROSION PROTECTION AS REQ'D BY ALL GOVERNING AUTHORITIES.
- 2. PROVIDE P.T. WD. WHERE IN CONTACT W/ EPOM ROOFING, FLASHING WATERPROOFING, MASONARY, CONCRETE OR EARTH.
- 3. ALL WOOD FASTENERS, HANGERS, ETC. IN CONTACT w/. P.T. WD. TO RECEIVE MIN. G90 GALV OR GREATER AS REQD. BY FASTENER MFR.

FOR TYPE OF P.T. CHEMICAL USED AND/OR ENVIROMENT.

- 4. CONFORM TO ELECRIC REQTS. OF NEC 2002 INCL. GFIC RECEPTS. & GROUNDING OF CONC. SLABS ANIMAL USE AREAS.
- 5. LIGHTNING PROTECTION WILL BE INSTALLED COMPLYING w/ NFPA 780
- P.T. ? POSTS EXTERIOR WALLS & AISLE P.T. ? POSTS @ DUTCH DOORS
- P.T. ? POSTS @ STALL DOORS 7. CONC. FOOTERS ARE SIZED ASSUMING A
- MIN. SOIL BEARING CAPACITY OF 3000 PSF
- 8. STALLS TO HAVE STONE BASE WITH 3/4" RUBBER STALL MATS ON TOP 9. CENTER AISLE AND TACK ROOM TO HAVE 4" THICK CONCRETE FLOOR
- 10. STALL FRONTS TO BE 2x8 T&G SYP PLANKS 4' HIGH WITH 36" HIGH METAL GRILL ON TOP
- 11. STALL PARTITIONS TO BE 2X8 T&G SYP 4' HIGH WITH 36" METAL GRILL ON TOP
- 12. TOTAL AREA UNDER ROOF (INCLUDES OVERHANGS) ? SQ.F.

DO NOT SCALE DIMENSIONS OFF DRAWINGS. USE WRITTEN OR CALCULATED

- ALL CONTRACTORS ARE RESPONSIBLE FOR CHECKING DIMENSIONS BEFORE ESTIMATING, ORDERING OR STARTING WORK.
- ALL WORK SHALL CONFORM TO CODES AND REQUIREMENTS OF LOCAL, COUNTY, STATE, NATIONAL BUILDING SAFETY CODES AND OTHER AGENCIES AND AUTHORITIES HAVING JURISDICTION OVER THE PROJECT.

CODE INFO. ON STRUCTURE:

CONSTRUCTION TO CONFORM WITH DESIGN DOCUMENTS & ALL CODE REQTS. 1. FOUNDATIONS DESIGNED FOR ASSUMED ALLOWABLE NETSOIL BEARING PRESSURE OF 3000 PSF

- 2. DESIGN LIVE LOADINGS AS FOLLOWS: - LOFT FLOOR: PSF - SNOW: 45 PSF GROUND SNOW LOAD - WIND: 110 MPH (EXPOSURE C) - SEISMIC USE GROUP: 1 - SITE CLASS: D - SEISMIC FORCE RESIST: WD. FRAME - WEATHERING: SEVERE 3. DEAD LOADS AS FOLLOWS: - ROOF w/. SHINGLES - 10 PSF - WOOD FLOOR - 10 PSF
- 4. PLACE FILL & BACKFILL IN MAX. 8" LIFTS. COMPACT EACH LAYER UNDER FOOTINGS & SLABS TO A DRY DENSITY OF MIN. 95%. DO NOT BUILD ON SOILS LESS THAN INDICATED DESIGN STRENGTH.
- 5. CONCRETE TO HAVE 28-DAY MIN. COMPRESSIVE STRENGTH AS FOLLOWS: - 4000 PSI AT EXT. SLABS - 3000 PSI ALL OTHER LOCATIONS
- PROVIDE COVERING OF REINF. PER IBC TABLE 1907.7.1 PROVIDE CORNER BARS TO MATCH CONTIN. REIFN. LAP ALL REINF. MIN 24" W.W.F. TO LAP MIN. 8".

6. ALL STRUCTURAL WOOD TO BE GRADED LUMBER - MIN. S.P.F. OR #2 HEM-FIR UNLESS NOTED OTHEWISE.

- 7. CONTRACTOR IS RESPONSIBLE OF MEANS OF CONSTRUCTION, INCL. PROVIDNG GUYS, BRACING & SHORING AS REQUIRED FOR ALL LOADING CONDITIONS THROUGHTOUT CONSTRUCTION. CONTRACTOR IS NOT TO STORE MATERIALS IN EXCESS OF DESIGN LIVE LOADS WITHOUT APPROVAL OF ARCHITECTOR.
- 8. ALL STAIRS & RAILING TO CONFORM w/. LOADING REQTS. IN CODE
- 9. CONCRETE FLOOR SLAB-ON-GRADE TO INCLUDE CONTROL JOINTS A MAXIMUM OF 12' O.C. AND 1/4" OF THE SLAB THICKNESS. ALL TOPSOIL, ORGANICS AND CLAY TO BE REMOVED FROM FLOOR SLABS PRIOR TO CONCRETE OR FILL PALECEMENT. FILLS TO BE NON-EXPANSIVE GRANULAR SOIL, PLACED IN 6-8 INCH LIFTS AND COMPACTED TO 95% OF THE MAXIMUM PROCTOR DENSITY AND WITHIN 2% OF OPTIMUM MOISTURE CONTENT.

SYMBOL LEGEND



__ 40"x25" 8-LITE SLIDING WINDOW WITH WINDOW GRILL

 $\langle W2 \rangle$ 24"x40" SINGLE HUNG WINDOW


1 DETAIL NUMBER A.1 - SHEET DETAIL IS LOCATED




A.1 SHEET SECTION IS LOCATED

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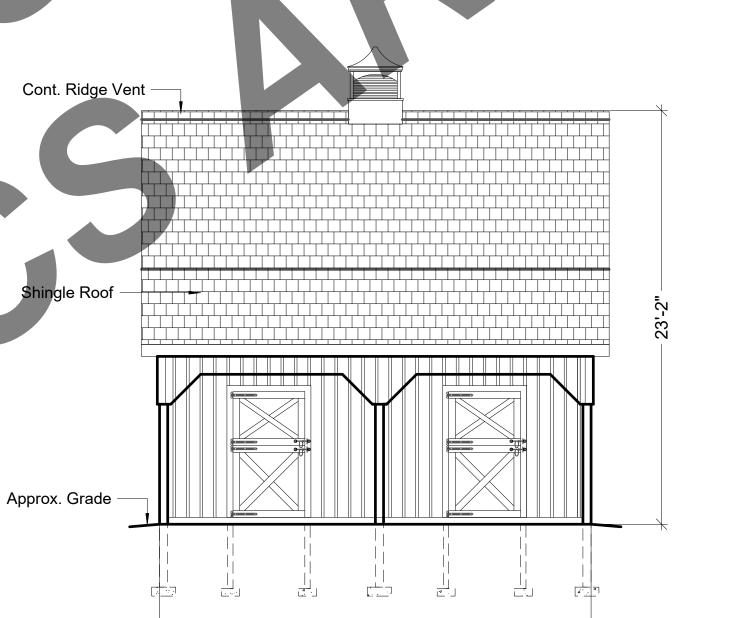
LOFT PLAN


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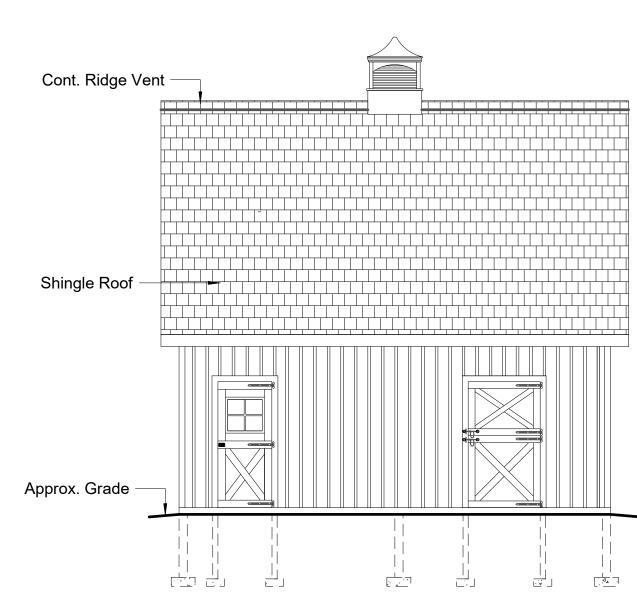


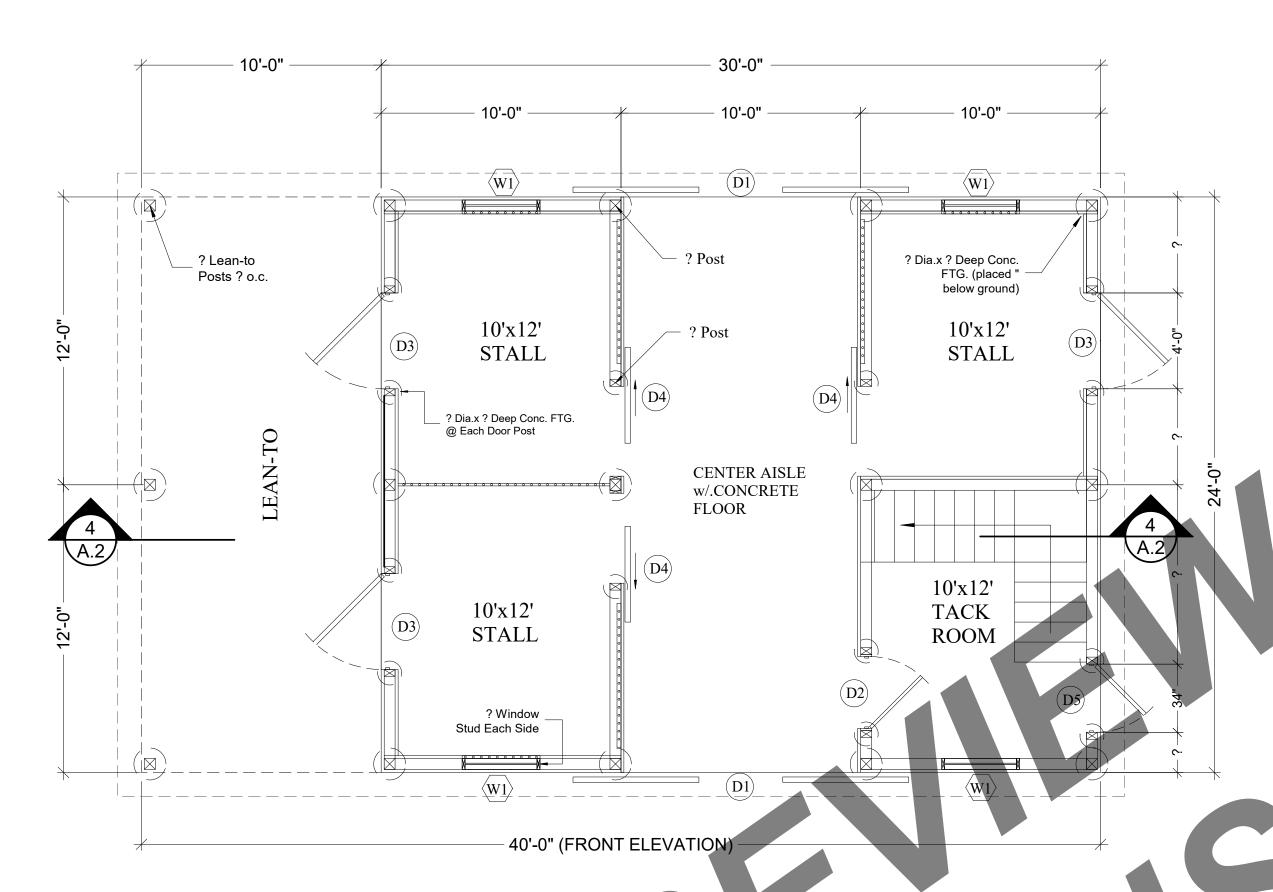1x10 White Pine Board & Batten Siding

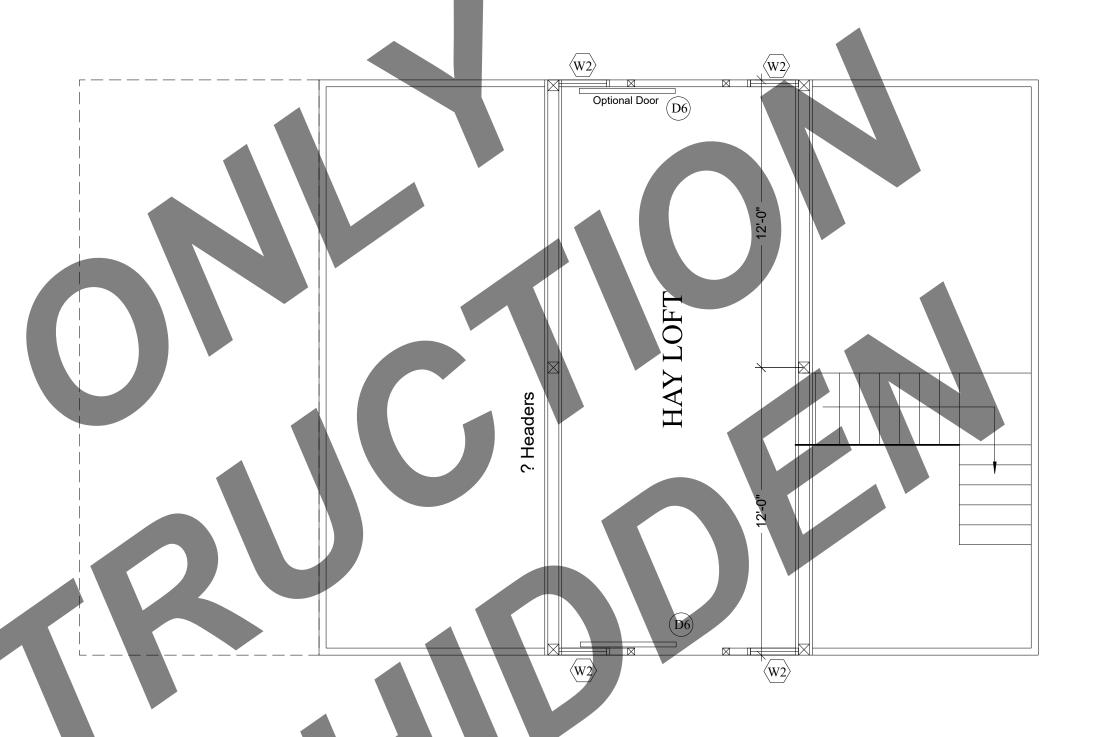FRONT & REAR ELEVATIONS





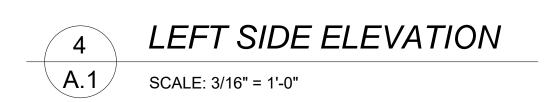



FILE INFO.

SEAL

PROJECT NO.

DRAWN BY


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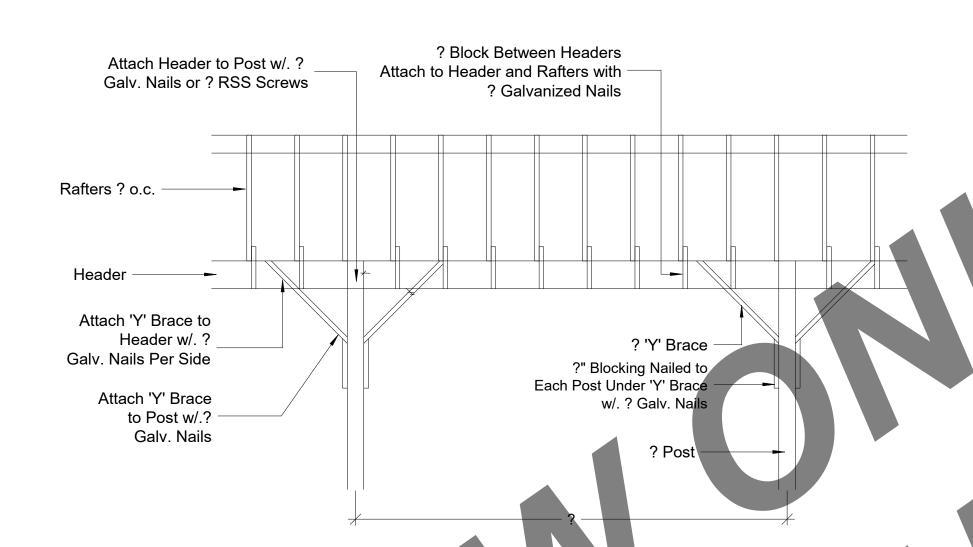
REVISIONS


DRAWING TITLE

FLOOR PLAN **EXTERIOR ELEVATIONS**

SHEET NO. **A.**1




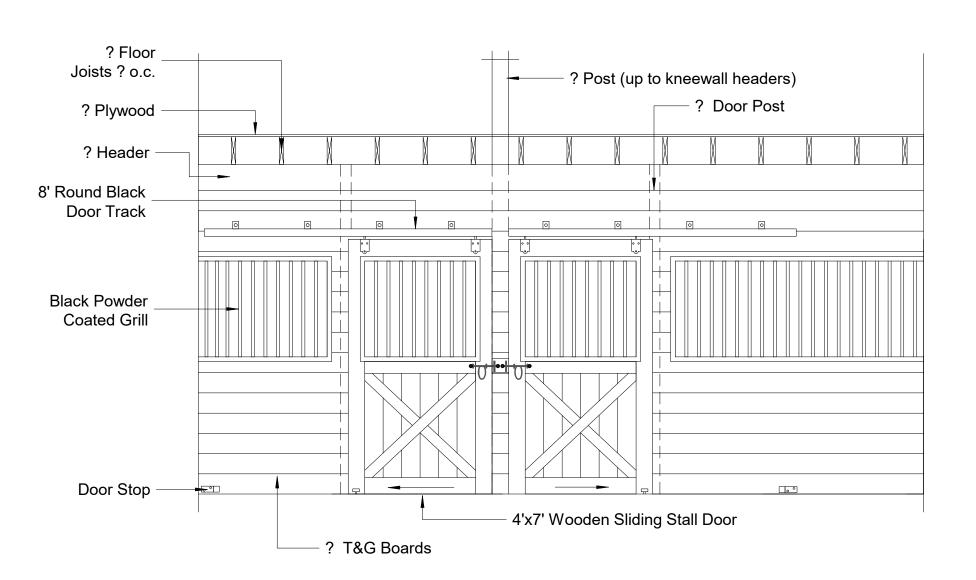

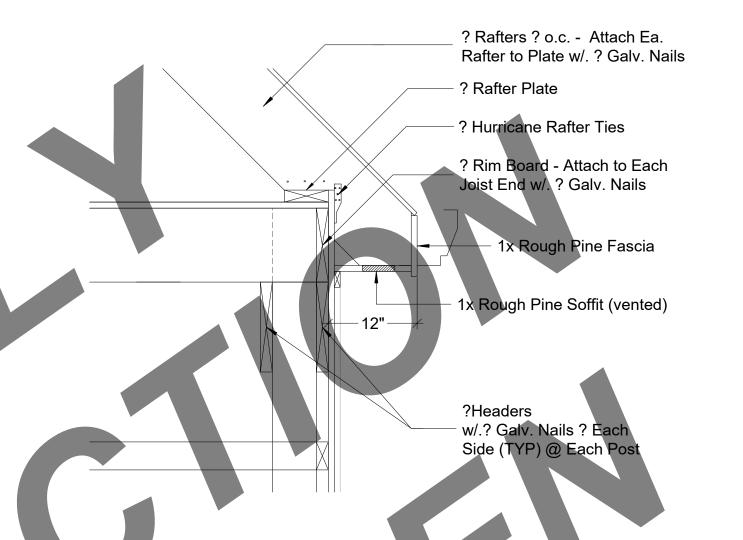


TYP. STALL ELEVATION A.2 | SCALE: 3/8" = 1'-0"

OVERHANG DETAIL SCALE: 1" = 1'-0'

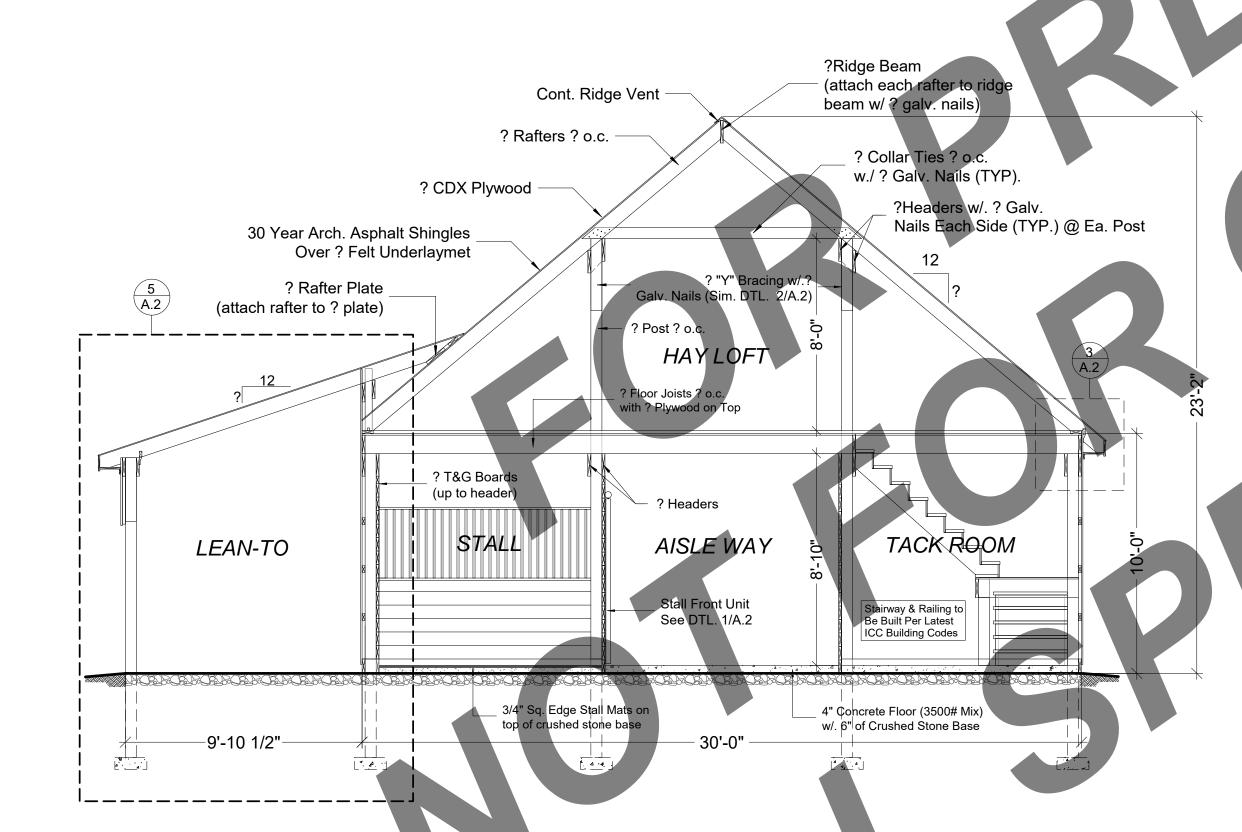


BUILDING SECTION

SCALE: 1/4" = 1'-0"

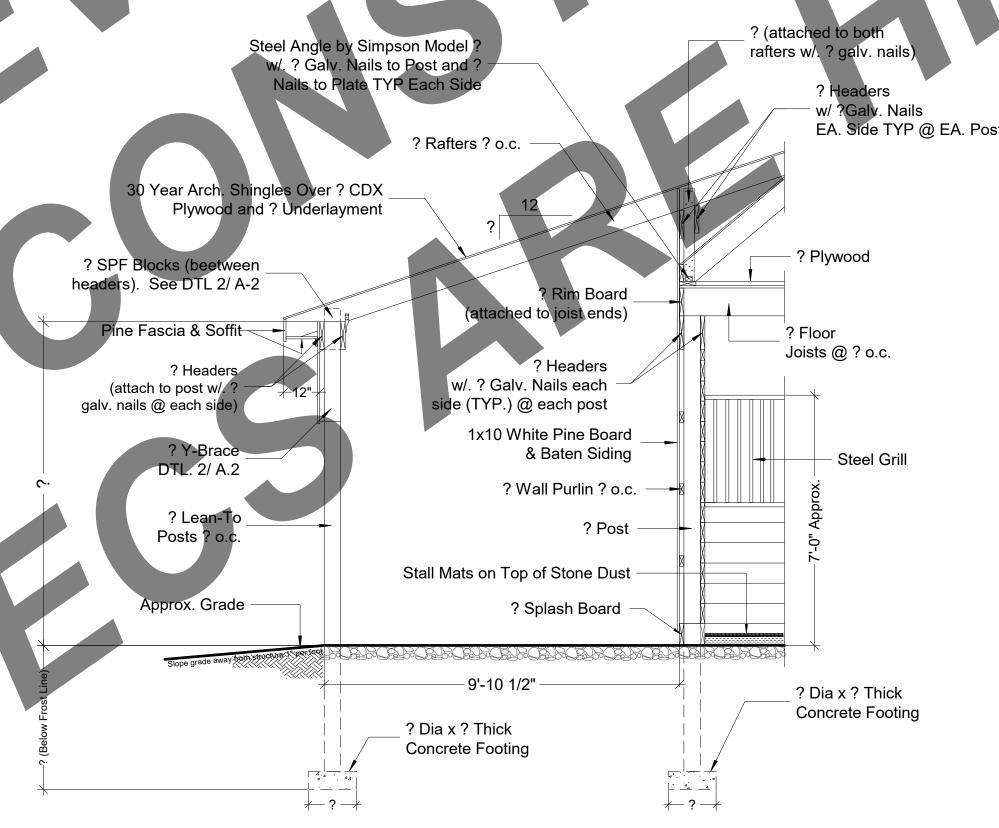

A.2 SCALE: 3/8" = 1'-0"

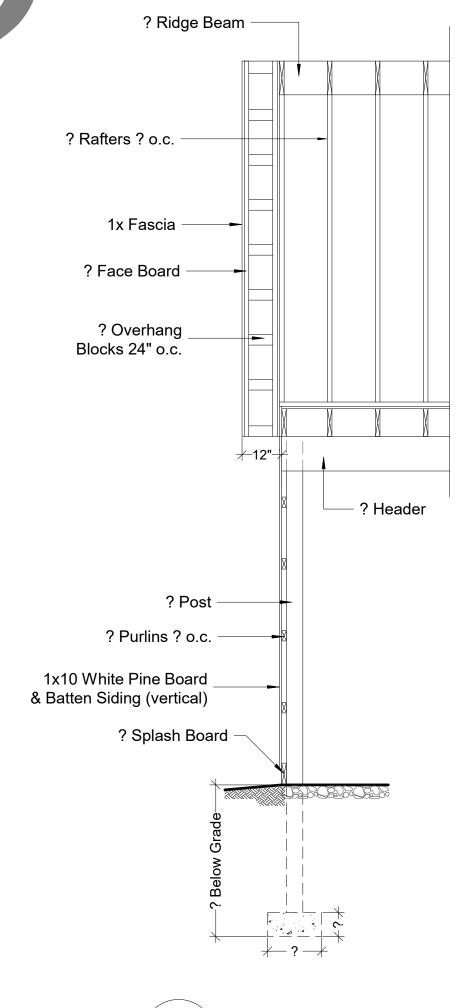

WALL SECTION A.2 | SCALE: 3/8" = 1'-0"

LEAN-TO OVERHANG

DRAWING TITLE

DATE

SEAL

PROJECT NO.

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FILE INFO.

REVISIONS

FILE INFO.

STALL FRONT DETAIL
'Y' BRACE DETAIL BUILDING SECTION LEAN-TO DETAIL WALL SECTION

SHEET NO. **A.2**

